


8 7 6 5 4 3 2 1

BILL OF MATERIAL				
ITEM	QTY	DESCRIPTION	CTS P/N	MFG P/N

HOME/GUEST 6-DIGIT SCOREBOARD DISPLAY
1 REQUIRED
P/N: LED6-HG
(BY COLORADO TIME SYSTEMS)
WEIGHT 40lbs EACH

8'-3 1/4"
[2.52M]

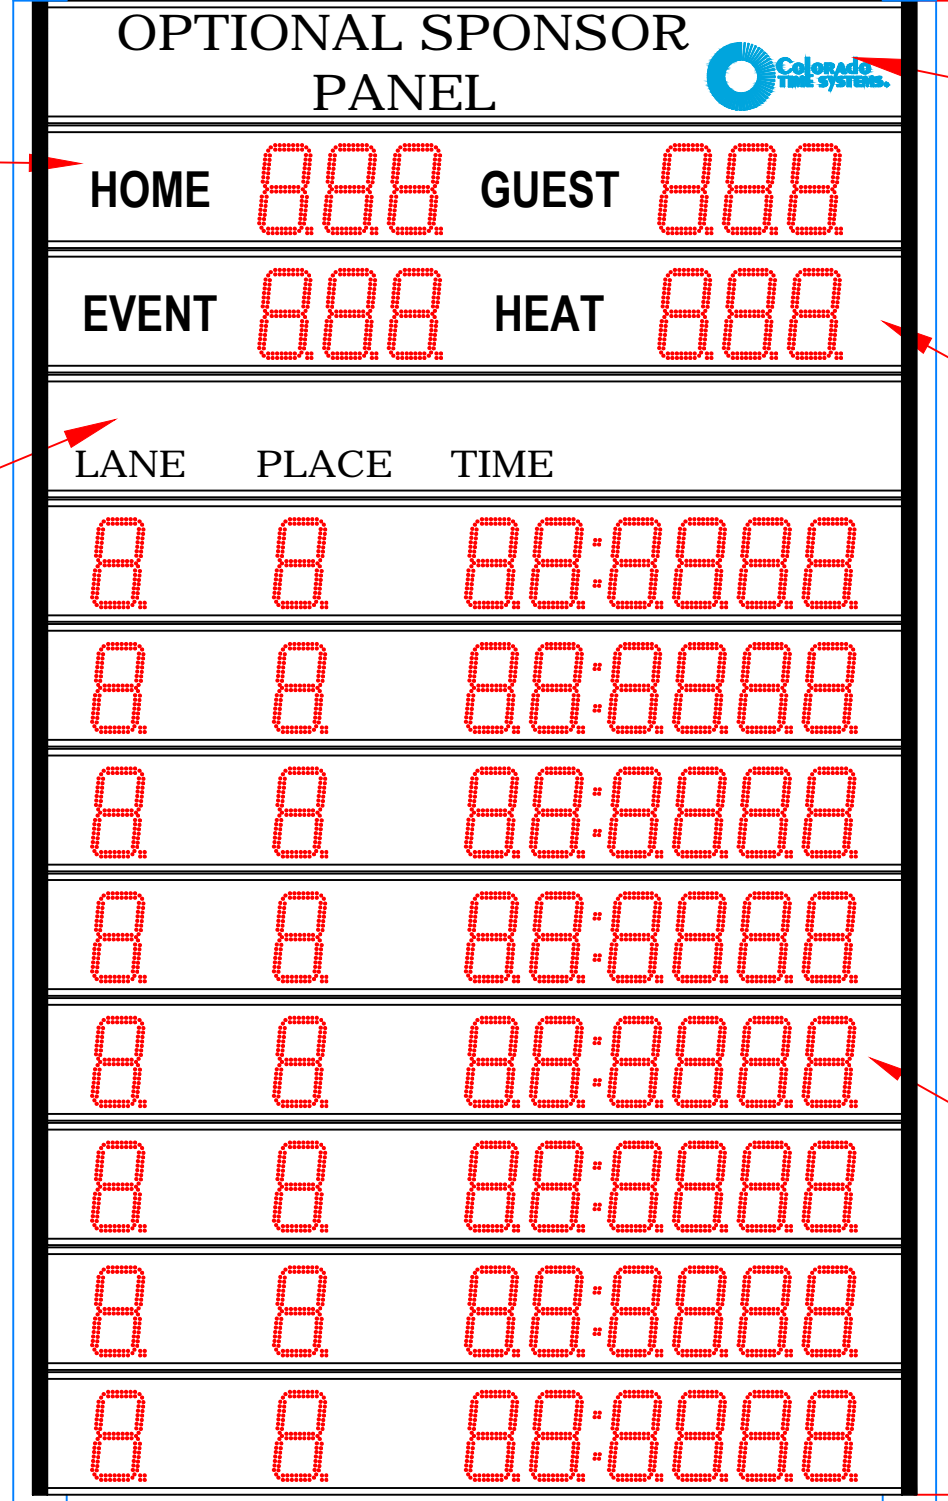



OPTIONAL SPONSOR PANEL
SPONSOR PANEL ASSEMBLY
2 REQUIRED
P/N SP-LED WITH OPTIONAL ARTWORK
(BY COLORADO TIME SYSTEMS)
WEIGHT 26lbs EACH

EVENT/HEAT 6-DIGIT SCOREBOARD DISPLAY
1 REQUIRED
P/N: LED6-EH
(BY COLORADO TIME SYSTEMS)
WEIGHT 40lbs EA


13'-11 3/4"
[4.26M]

LANE PLACE TIME 8-DIGIT SCOREBOARD DISPLAY
8 REQUIRED
P/N: LEDR
(BY COLORADO TIME SYSTEMS)
WEIGHT 40lbs EA

LANE PLACE TIME SCOREBOARD DISPLAY
P/N: SP-LED WITH LN/PL/TIME
(BY COLORADO TIME SYSTEMS)
WEIGHT 26lbs EACH

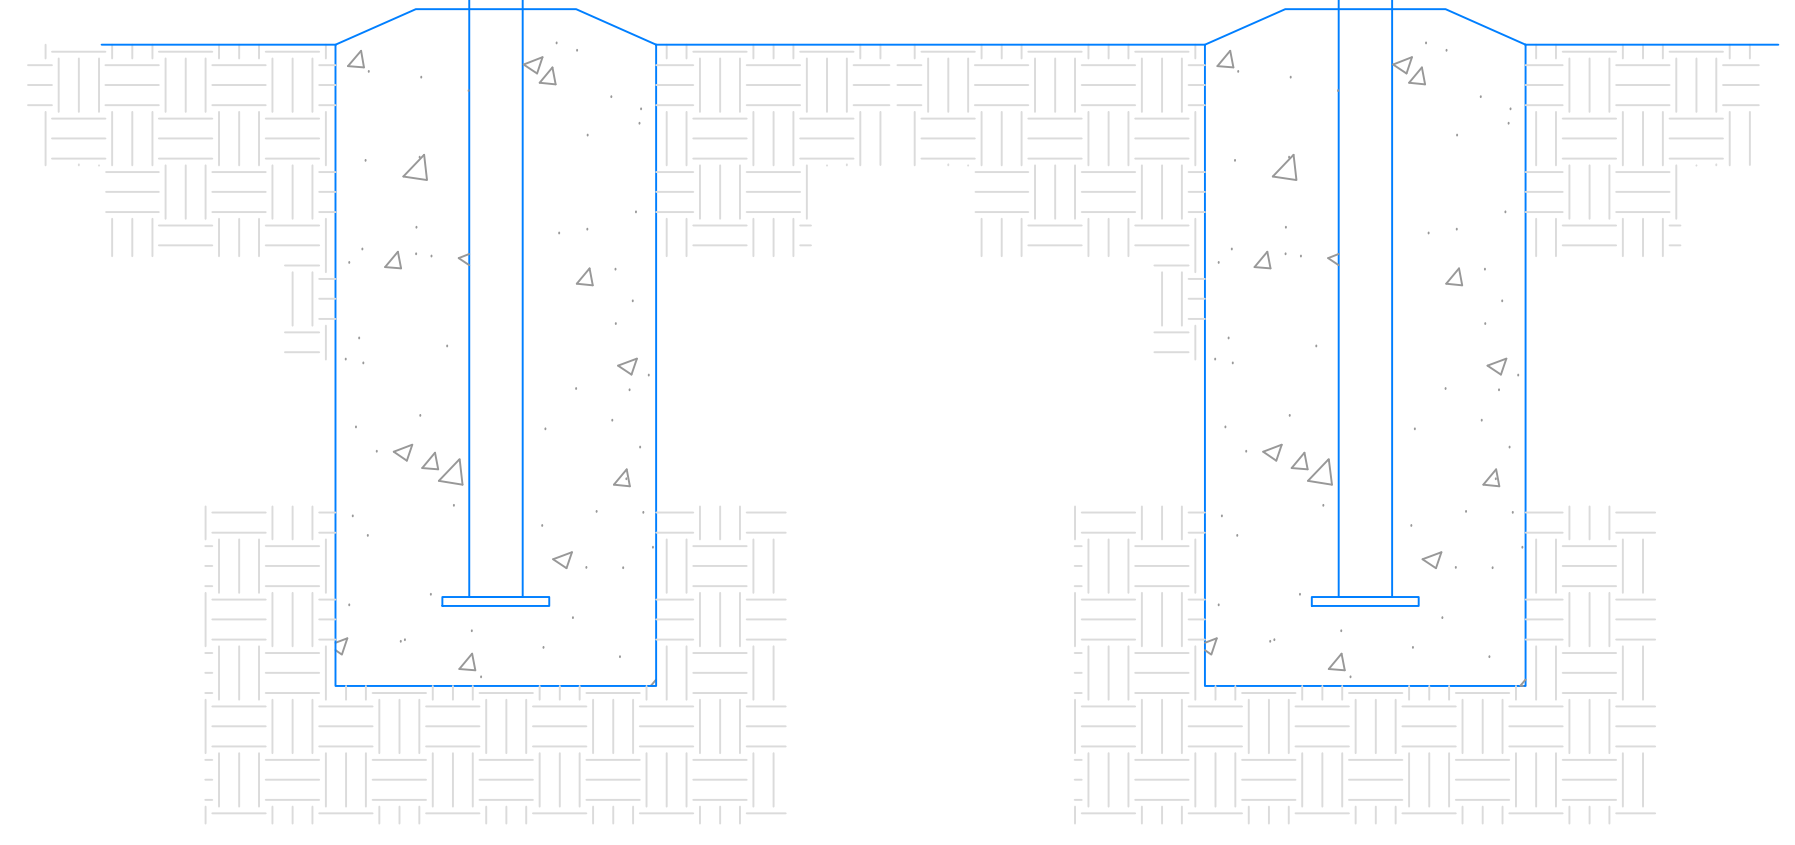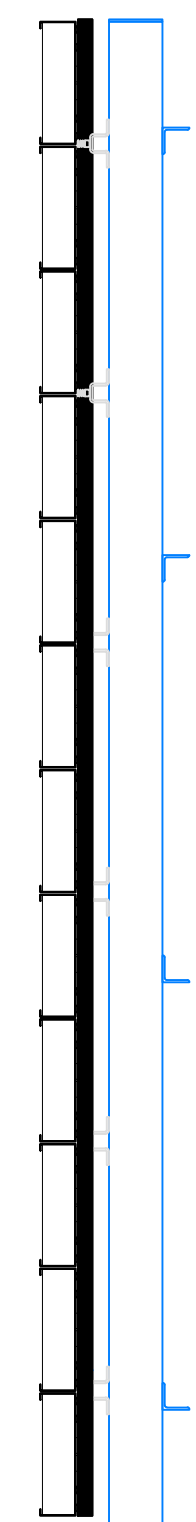


FRONT VIEW

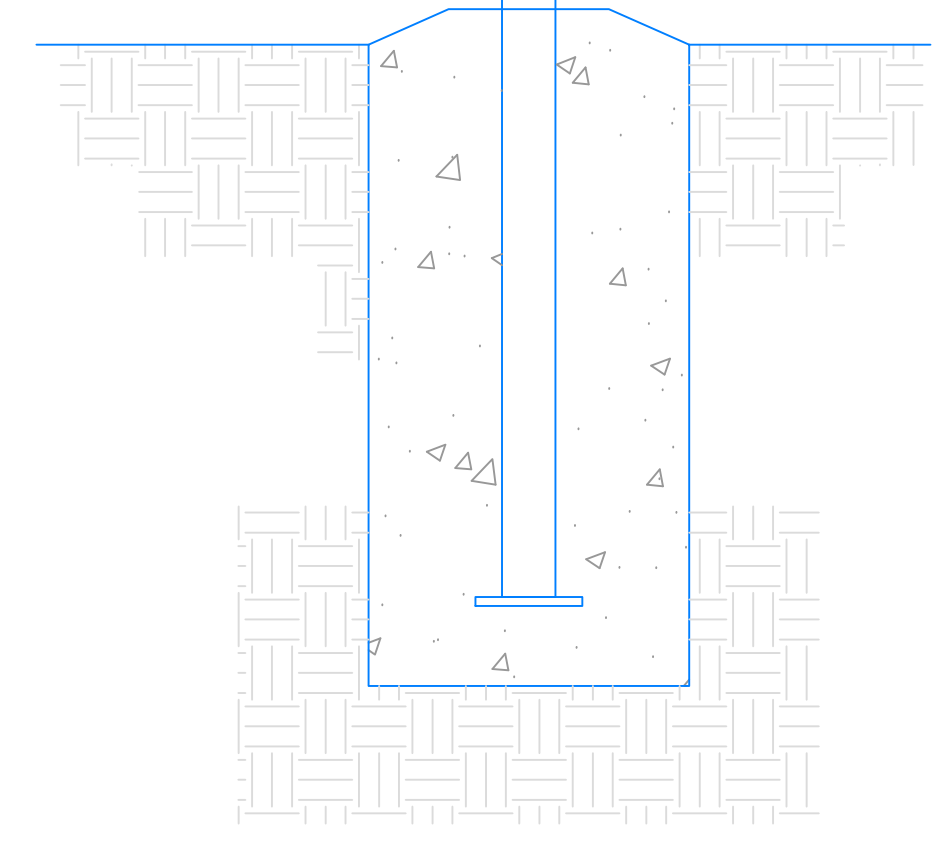

SIDE VIEW

- NOTES:
- TOTAL WEIGHT - 452 LBS - INCLUDES DISPLAY PORTION ONLY
 - DIMENSIONS ARE APPROXIMATE AND ARE SUBJECT TO CHANGE DUE TO DETAILED DESIGN CONSIDERATIONS
 - THIS DRAWING FOR DESIGN ONLY - PLEASE CONSULT CTS PRIOR TO ANY FABRICATION/INSTALLATION
 - ONLY APPROVED SHOP DRAWINGS SHOULD BE USED FOR CONSTRUCTION
 - ALL CONSTRUCTION AND FABRICATION MUST MEET ALL APPLICABLE LOCAL, STATE, AND NATIONAL CODES
 - ALL ON-SITE WORK TO BE DONE IN ACCORDANCE WITH OSHA AND ALL LOCAL CODES THAT APPLY
 - CTS PROVIDES DISPLAY, UNISTRUT, AND BRACKETING - ALL OTHER STRUCTURAL COMPONENTS AND FABRICATION MUST BE PROVIDED BY OTHER

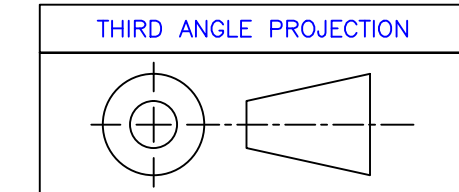

UNLESS OTHERWISE SPECIFIED:
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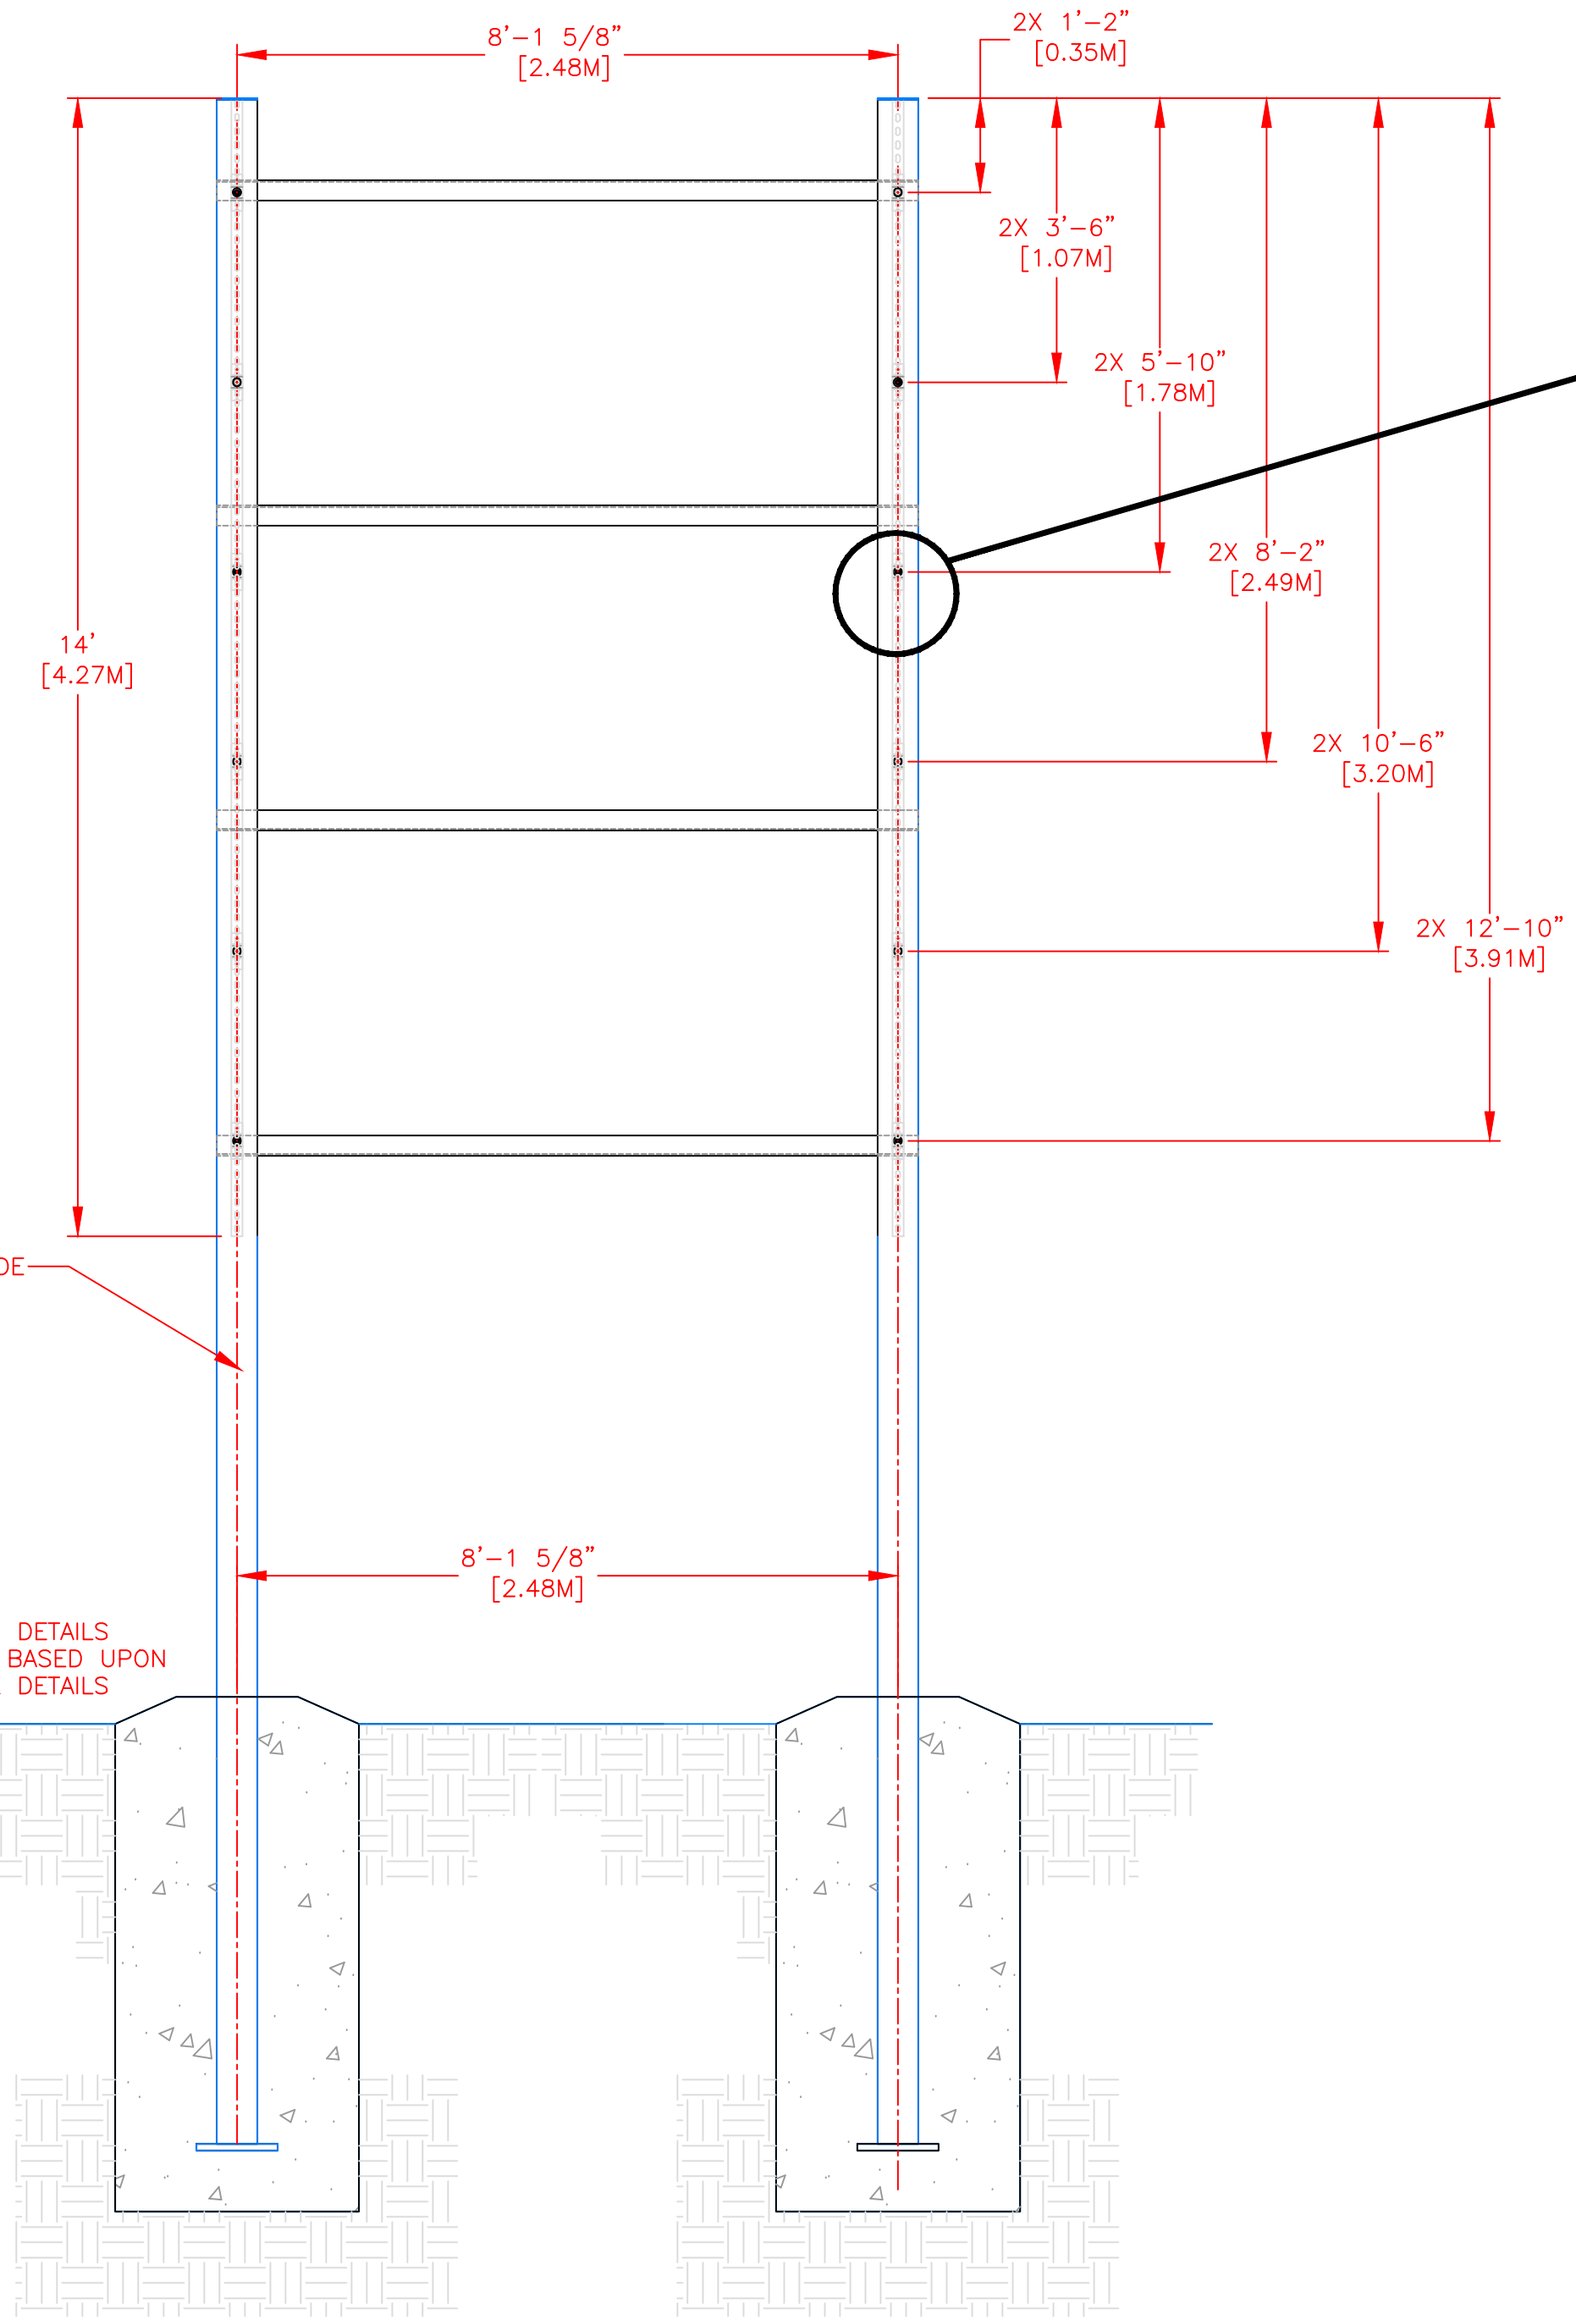
REV	DESCRIPTION	ECO/PCO #	DATE	APPROVED
A	INITIAL RELEASE		8/9/12	ERS

<p>ALL DIMS IN INCHES UNLESS OTHERWISE NOTED INCH [MM] 1 INCH = 25.4MM TOLERANCES EXCEPT AS NOTED</p> <p>INCHES .X ± N/A .XX ± N/A .XXX ± N/A MM .X ± .XX ±</p> <p>ANGLES ± 1°</p> <p>MATERIAL SEE BILL OF MATERIAL FINISH</p>	<p>DRAWN BY C. CARR DATE 8/9/12 ENG. APPROVAL PROJECT ENG.</p> <p>DO NOT SCALE THIS DRAWING</p> <p>TRADE SECRET</p> <p>The information and data contained herein is secret and is submitted in confidence, and shall not be disclosed, used, or duplicated for any purpose whatsoever without the prior written permission of Colorado Time Systems, Inc., 1551 E. 11th Street, Loveland, Colorado, 80537. This legend shall be marked on any reproduction hereof in whole or in part. Receipt of this document shall be deemed to be an acceptance of the conditions specified herein.</p>	<p>1551 E. 11th St. Loveland, CO 80537 P: (970) 667-1000 F: (970) 667-5876</p> <p>Colorado TIME SYSTEMS</p> <p>TITLE 8 LANE SWIM 2-POLE HOME/GUEST EVENT/HEAT NEXT ASSEMBLY</p> <p>SIZE D DRAWING NUMBER D108-1-2-12-005 SCALE 1/2"=1' SHEET 1 OF 3</p>
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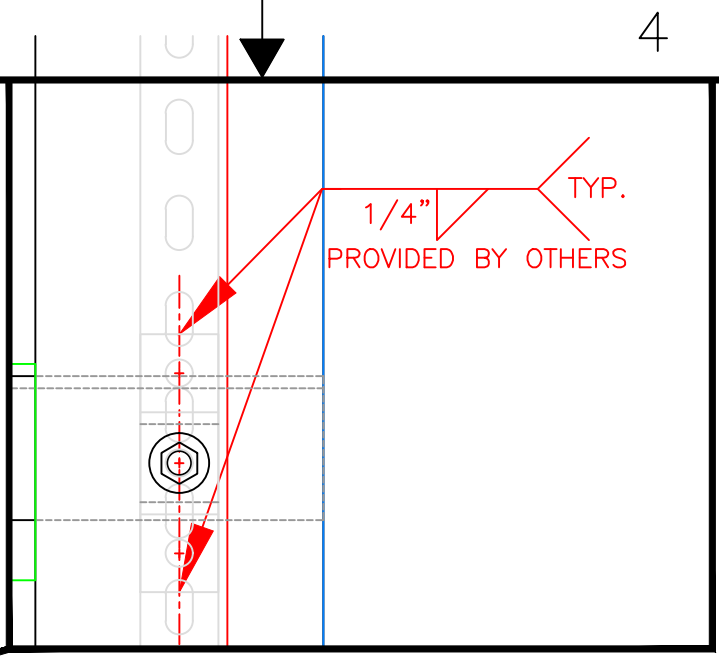
8 7 6 5 4 3 2 1

8 7 6 5 4 3 2 1


BILL OF MATERIAL				
ITEM	QTY	DESCRIPTION	CTS P/N	MFG P/N




FRONT VIEW



UNISTRUT MOUNTING BRACKET DETAIL
SCALE: 6"=1'
TYPICAL 12 PLCS

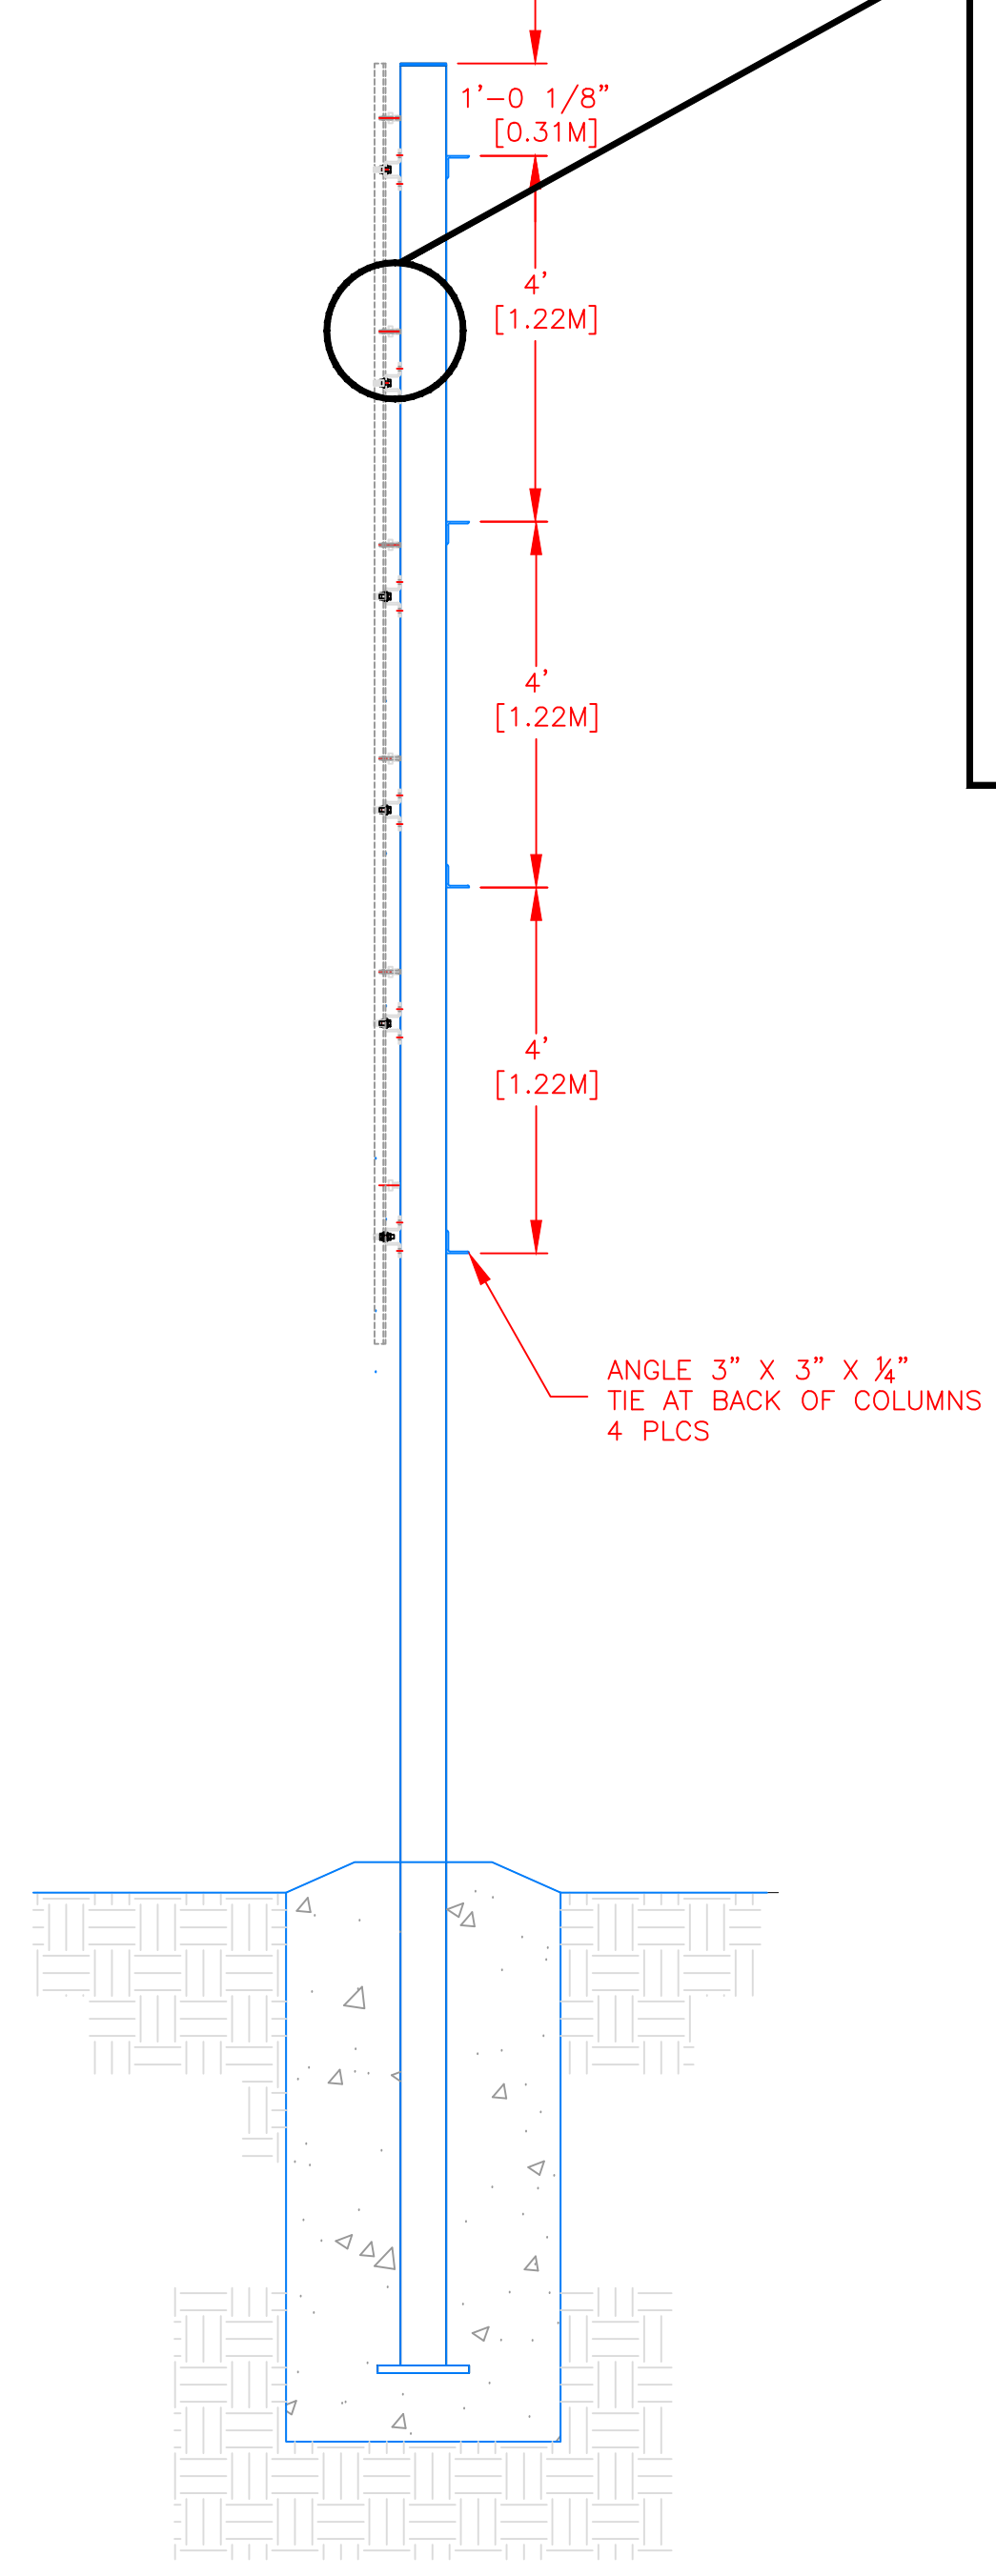

SIDE VIEW

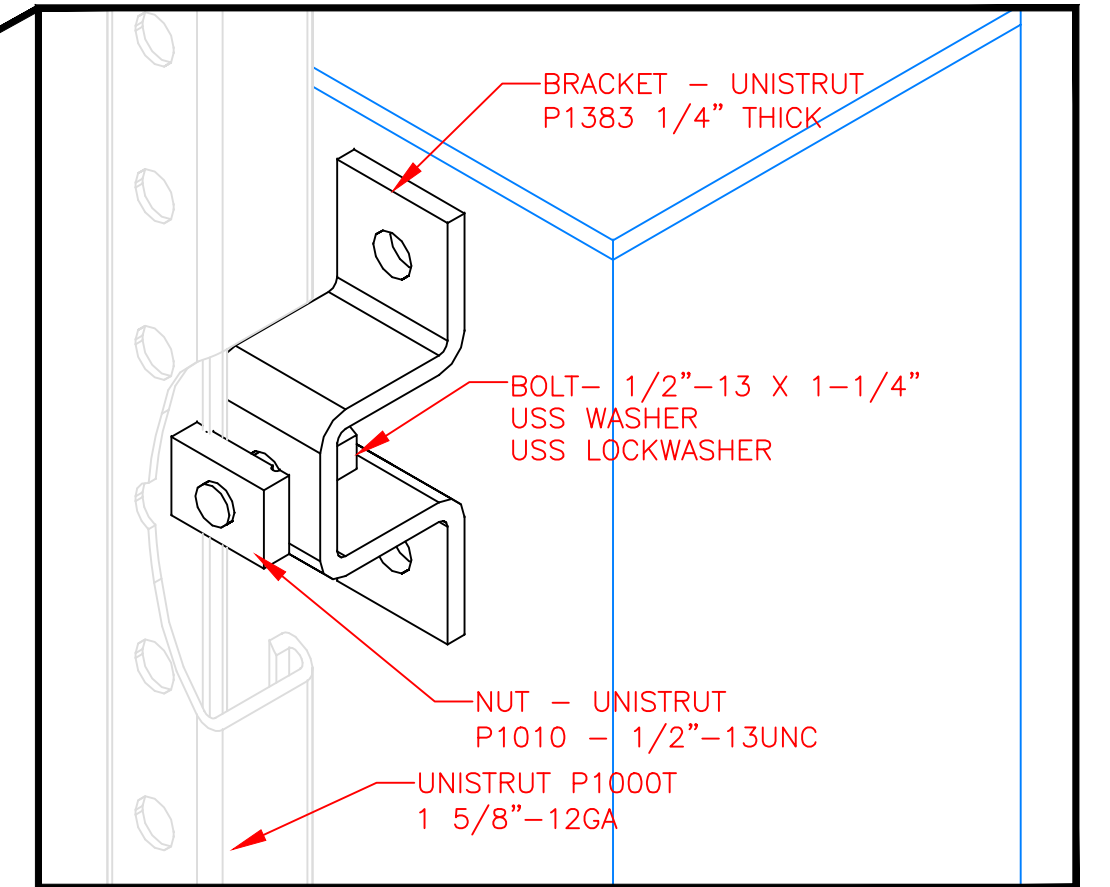

UNISTRUT MOUNTING HARDWARE DETAIL
SCALE: 6"=1'

COLUMNS MUST BE AT LEAST 6" WIDE

COLUMN & FOOTING DETAILS TO BE DETERMINED BASED UPON LOCAL WIND & SOIL DETAILS

ANGLE 3" X 3" X 3/8" TIE AT BACK OF COLUMNS 4 PLCS

REV	DESCRIPTION	ECO/PCO #	DATE	ERS APPROVED
A	INITIAL RELEASE		8/9/12	ERS

REVISIONS


ALL DIMS IN INCHES UNLESS OTHERWISE NOTED INCH [MM] 1 INCH = 25.4MM	DRAWN BY C. CARR	DATE 8/9/12	<p>1551 E. 11th. St. Loveland, CO 80537 P: (970) 667-1000 F: (970) 667-5876</p>
TOLERANCES EXCEPT AS NOTED	ENG. APPROVAL	PROJECT ENG.	
INCHES .X ± N/A .XX ± N/A .XXX ± N/A	MM .X ± .XX ±	DO NOT SCALE THIS DRAWING	TITLE 8 LANE SWIM 2-POLE STRUCTURAL DETAILS
ANGLES ± 1°	MATERIAL SEE BILL OF MATERIAL	FINISH	SCALE 1/2"=1'
<p>UNLESS OTHERWISE SPECIFIED: VARIATIONS IN FORM FOR UNMACHINED FEATURES ARE PERMITTED WITHIN ESTABLISHED COMMERCIAL STANDARDS. ALL EDGES AND CORNERS 0.005-0.020 (APPROX RADIUS OR CHAMFER) - ALL FILETS 0.005-0.020 (APPROX RADIUS) - SCREW THREADS PER ANSI B1.1 - PIPE THREADS PER ANSI B1.1 - SURFACE ROUGHNESS PER ANSI B46.1 - SURFACE ROUGHNESS ON HOLES 250 MAX</p>			<p>TRADE SECRET</p> <p>THE INFORMATION AND DATA CONTAINED HEREIN IS SECRET AND IS SUBMITTED IN CONFIDENCE, AND SHALL NOT BE DISCLOSED, USED, OR REPRODUCED FOR ANY PURPOSE WHATSOEVER WITHOUT THE PRIOR WRITTEN PERMISSION OF Colorado Time Systems, Inc., 1551 E. 11th Street, Loveland, Colorado, 80537. This legend shall be marked on any reproduction hereof in whole or in part. Receipt of this document shall be deemed to be an acceptance of the conditions specified herein.</p>
<p>THIRD ANGLE PROJECTION</p>			<p>REVISIONS</p> <p>SIZE D 108-1-2-12-005 A</p> <p>DRAWING NUMBER SHEET 2 OF 3</p>

8 7 6 5 4 3 2 1

8 7 6 5 4 3 2 1

- NOTES:
1. EACH DUPLEX RECEPTACLE IS 125V, USE LEVITON #5352 OR EQUIVALENT.
 2. RECEPTACLES MUST BE IN PLACE BEFORE CTS INSTALLATION.
 3. POWER REQUIREMENTS: 120V, 1AMP PER SCOREBOARD MODULE MAXIMUM OF 16 MODULES PER 20A CIRCUIT.
 4. SINGLE GANG WALL BOX WITH BLANK PLATE FOR DATA CABLE. ONE REQUIRED PER DISPLAY.
 5. CONTROL CIRCUIT SHALL BE 125V 20A. NATIONAL ELECTRICAL CODE REQUIRES A MEANS OF DISCONNECT AT THE LOCATION OF THE SIGN. SCOREBOARD SHALL BE WIRED IN ACCORDANCE WITH NATIONAL ELECTRIC CODE ARTICLE 600-6.

***IT IS EXTREMELY IMPORTANT THAT THE CIRCUITS USED TO POWER THE SCOREBOARD NOT BE SHARED WITH OTHER DEVICES. THE SCOREBOARD IS SENSITIVE TO "NOISE" ON THE AC POWER LINE.

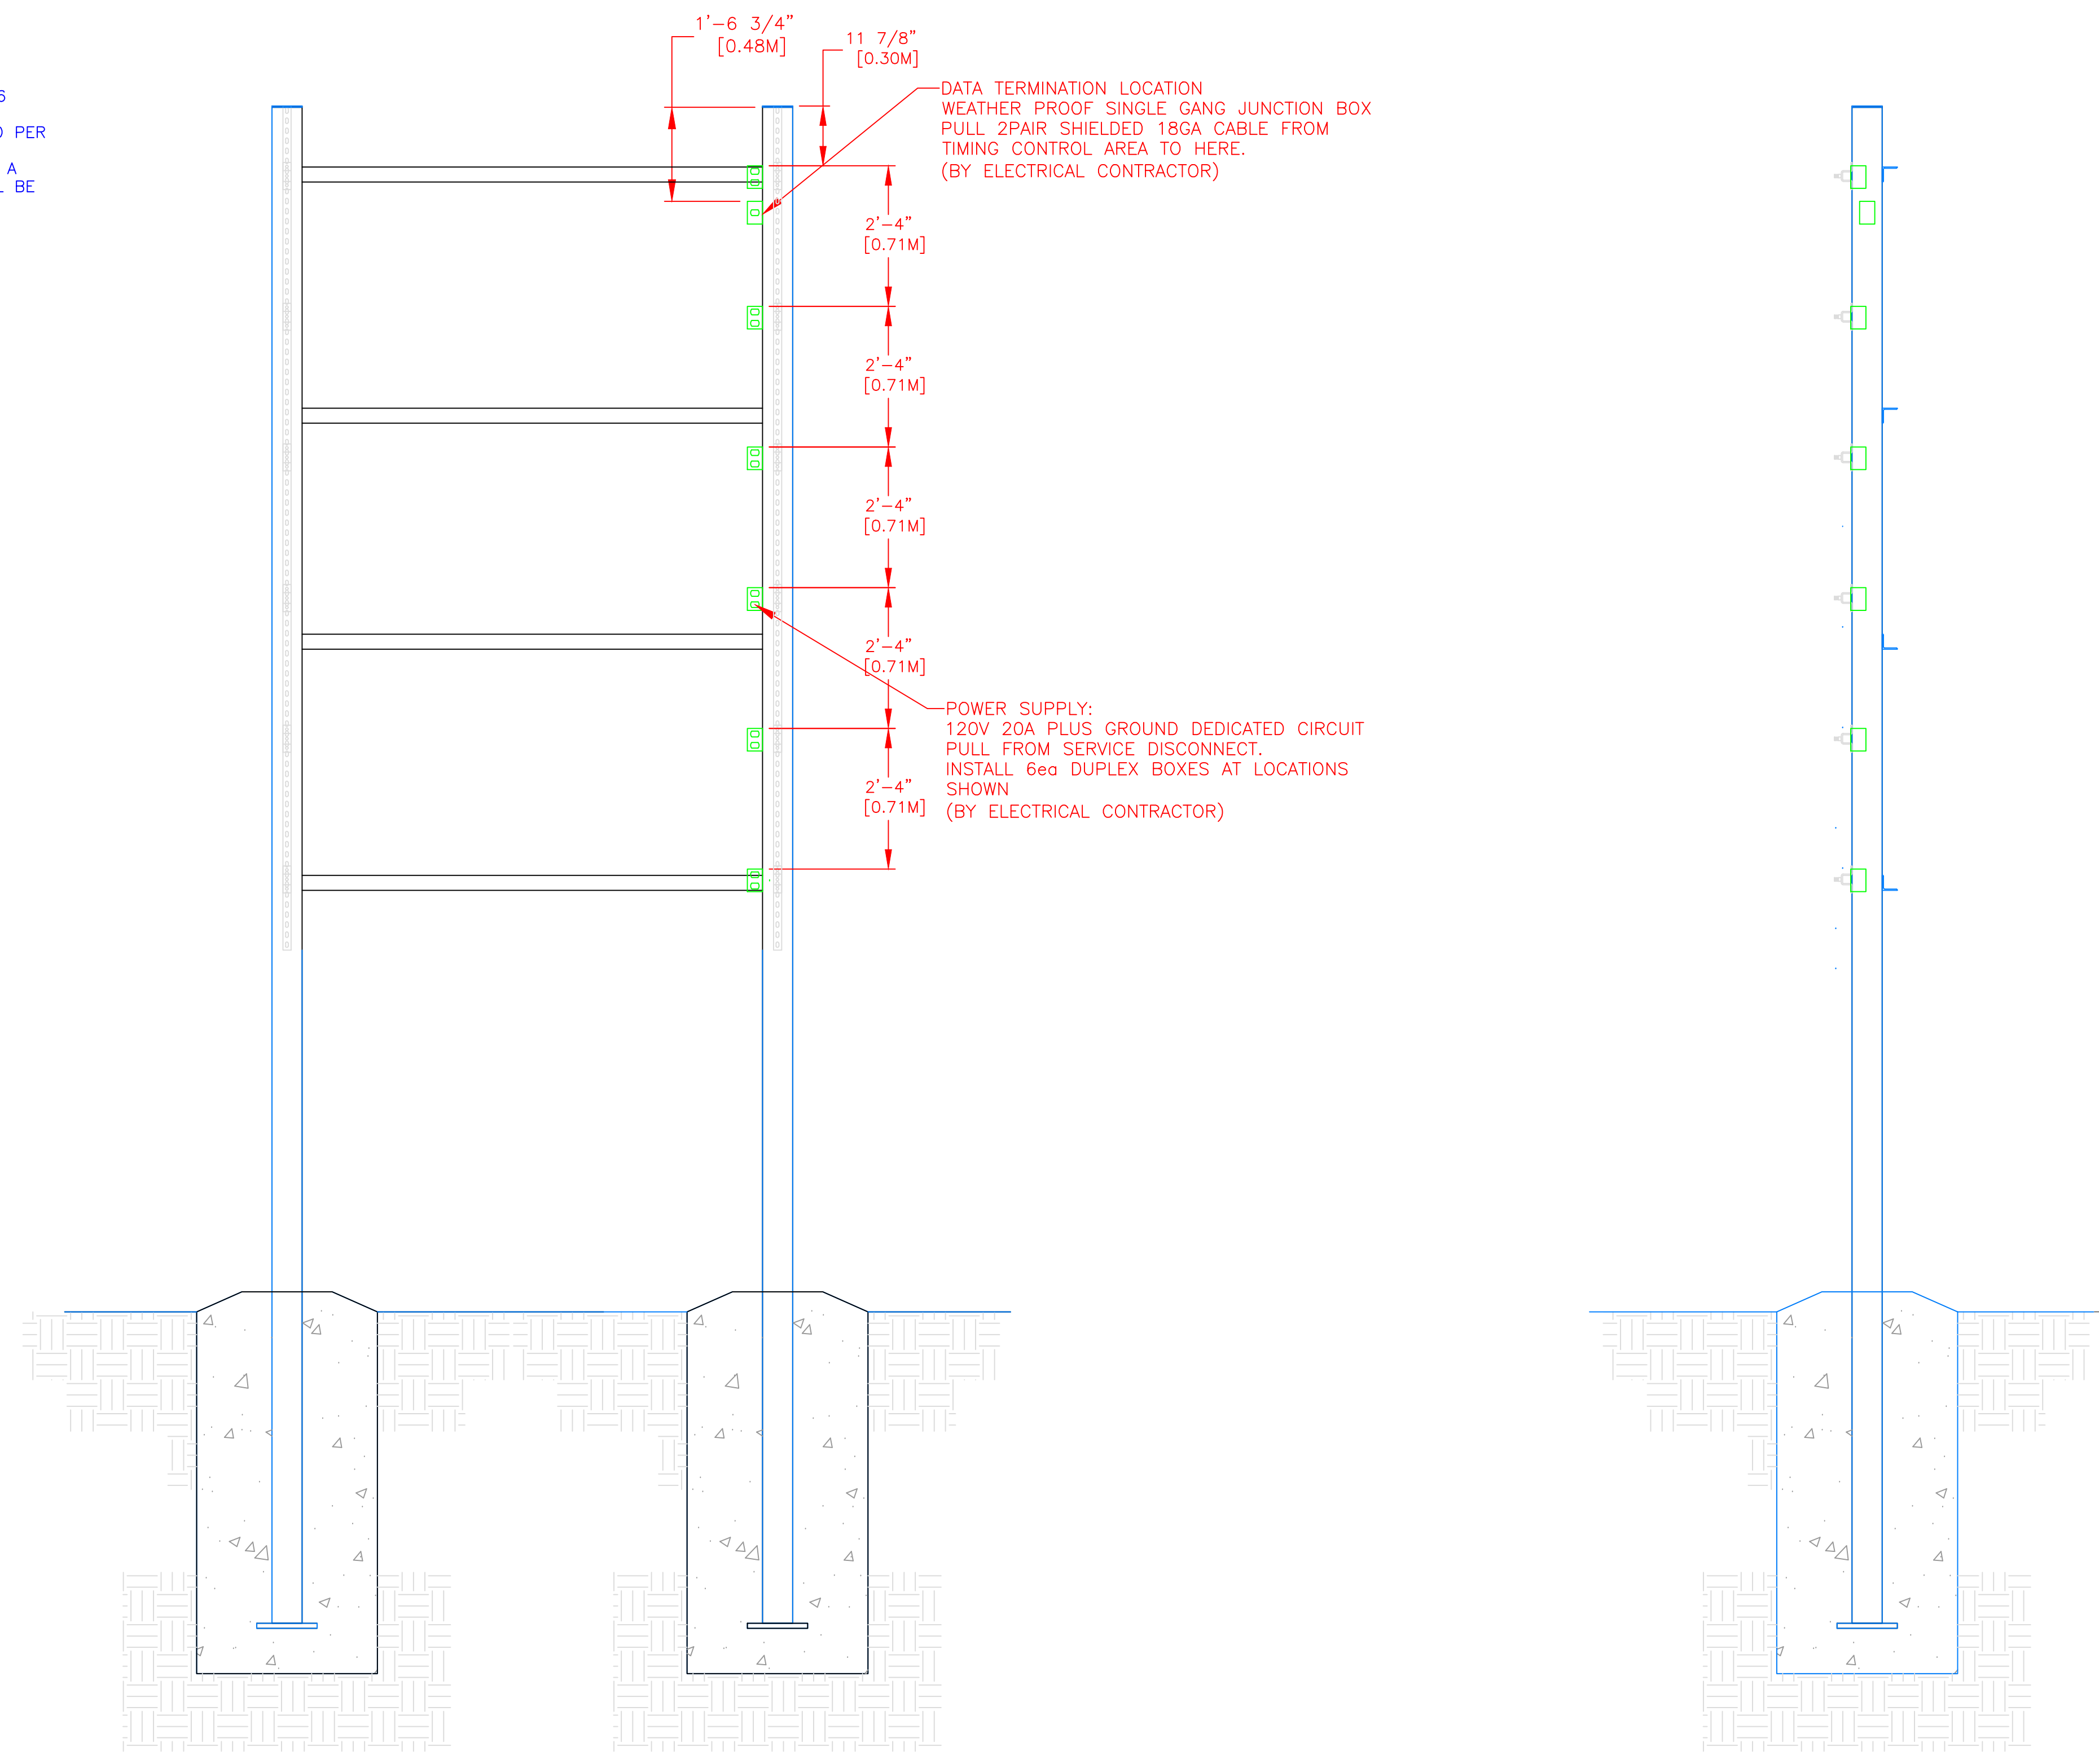


BILL OF MATERIAL				
ITEM	QTY	DESCRIPTION	CTS P/N	MFG P/N

SIDE VIEW

REV	DESCRIPTION	ECO/PCO #	DATE	ERS APPROVED
A	INITIAL RELEASE		8/9/12	ERS

<p>ALL DIMS IN INCHES UNLESS OTHERWISE NOTED INCH [MM] 1 INCH = 25.4MM TOLERANCES EXCEPT AS NOTED</p> <p>INCHES: .X ± N/A, .XX ± N/A, .XXX ± N/A MM: .X ±, .XX ±</p> <p>ANGLES ± 1°</p> <p>MATERIAL: SEE BILL OF MATERIAL FINISH:</p>	<p>DRAWN BY: C. CARR DATE: 8/9/12 ENG. APPROVAL: PROJECT ENG.:</p> <p>DO NOT SCALE THIS DRAWING</p> <p>TRADE SECRET</p> <p>The information and data contained herein is secret and is submitted in confidence, and shall not be disclosed, used, or duplicated for any purpose whatsoever without the prior written permission of Colorado Time Systems, Inc., 1551 E. 11th Street, Loveland, Colorado, 80537. This legend shall be marked on any reproduction hereof in whole or in part. Receipt of this document shall be deemed to be an acceptance of the conditions specified herein.</p>	<p>1551 E. 11th St. Loveland, CO 80537 P: (970) 667-1000 F: (970) 667-5876</p> <p>Colorado TIME SYSTEMS</p> <p>TITLE: 8 LANE SWIM 2-POLE ELECTRICAL DETAILS</p> <p>SIZE: D DRAWING NUMBER: 108-1-2-12-005 SCALE: 1/2"=1'</p>
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PLAN VIEW

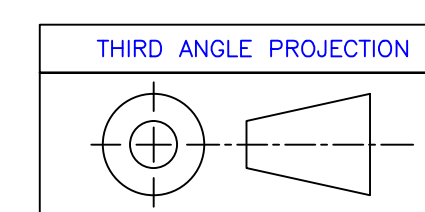8 7 6 5 4 3 2 1

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